

March 3, 2023

#### IFB 3105 HURT PARK ELEMENTARY SCHOOL SECURITY UPGRADES

#### Addendum #1

This addendum provides answers to questions received from contractors as of February 26, 2023, and includes revised plan sheets A041, A101, & E101 (attached).

#### **Questions & Answers:**

- Q1- Can we please confirm the manufacturers for the hollow metal frames, doors, and hardware? The five manufacturers listed are really only two. VT purchased Eggers and they're all merged now as one company – VT Industries. Algoma, Graham, and Marshfield no longer exist – they're all part of one company, Masonite Architectural.
- A1 Updated Manufacturers list is as follows:
  - Masonite Architectural
  - VT Industries
  - Chappell Door Company
  - Lambton Doors
  - Lynden Door, Inc
- Q2 Lead times on wood doors are currently 14 to 16 weeks, can we be sure that the contract will be in place quickly to allow for submittals to be completed and get doors on order?
   Lead times on hardware are currently about 6 weeks once ordered.
- A2 The Contract will be in place as soon as possible to allow for the GC to begin procuring materials. RCPS understands that lead times are of concern and the team is willing to work with the GC if other options are available to reduce lead time. Note that if lead times

become an issue, a temporary door will need to be provided at door 105 (new door into the clinic) until the permanent door arrives.

- **Q3** Can we confirm that the windows on the exterior of the building in the vestibule area will not require the security film to be installed?
- A3 Security film at the existing exterior storefront is only to be provided at Admin 102. See keynote A5 on 1/A101.
- Q4 Can we confirm that the new door to the Assistant Principal Office has no security film installed?
- A4 Please provide security film for the narrow lite in the door, see updated keynote G2 & door type elevation NT on sheet A101. Additionally, film is to be required at the existing hollow metal window. See keynote A7 on sheet A101.

### **GENERAL PROJECT INFORMATION**

PROJECT TYPE:

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RENOVATIONS TO

PROJECT NAME:	HURT PARK ELEMEN SECURED VESTIBUL								
PROJECT ADDRESS:	PROJECT ADDRESS: 1525 SALEM AVENUE SW ROANOKE, VA 24016								
SITE INFORMATION									
Tax map no.: Zoning: Flood Zone: Code Jurisdiction:	1210320 INPUD N/A CITY OF ROANOKE								
OWNER INFORMATION									
OWNER/AUTHORIZED AGENT: ROANOKE CITY PUBLIC SCHOOLS / JEFFERY SHAWVER PHONE: (540) 853-6306 JSHAWVER@RCPS.INFO									
OWNER'S ADDRESS:	PO BOX 13145 ROANOKE, VA 2403 <sup>4</sup>	PO BOX 13145 ROANOKE, VA 24031							
LEAD DESIGN PROFE	SSIONALS:								
<u>DISCIPLINE</u> 	FIRM 	<u>NAME</u> 	<u>LICENSE</u> 	TELEPHONE 					
 ARCHITECTURAL 	 SPECTRUM DESIGN 	 DAVID VENABLE 	 8832 	 540.342.6001 					
 ELECTRICAL 	 SPECTRUM DESIGN 	 JEFF WIGGINGTON 	 32781 	 540.342.6001 					

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### PROJECT CODE SUMMARY


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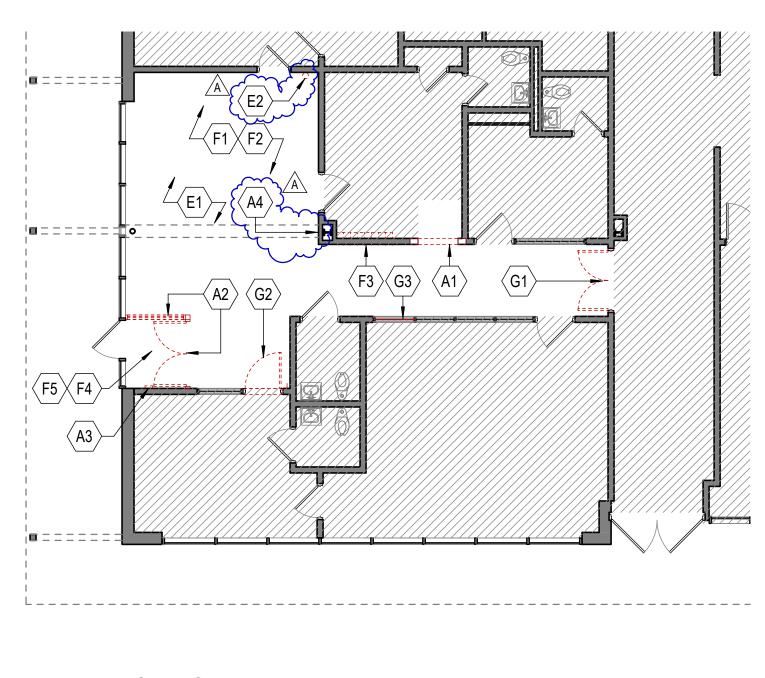
PROJECT								
		GENERALLY DESCRIBEI /ESTIBULE AREA	D AS A RENOVATION TO THE EXISTING LOBBY SPACE IN ORDER TO CREATE A					
APPLICAB	le Buil	DING CODES						
2018 VIRGI 2017 NATIC 2018 VIRGI 2018 VIRGI 2010 ADA S	INIA CO DNAL EL INIA ME INIA PLL STANDA		CC)					
BUILDING	INFORM	IATION						
ORIGINAL	BUILDIN	IG CONSTRUCTED:	1961					
EXISTING (	USES A	ND OCCUPANCIES:	E - EDUCATIONAL (PRIMARY); A - ASSEMBLY; B - BUSINESS					
NEW USES	S AND C	CCUPANCIES:	NO CHANGE					
NUMBER C	OF STOP	RIES:	1 STORY					
TOTAL BUI	ILDING /	AREA:	43,025 SF					
ACTUAL W	ORK AF	REA:	550 SF					
CONSTRUC	CTION 1	TYPE:	ASSUMED 2B, UNPROTECTED, NONCOMBUSTIBLE					
AUTOMATI	IC SPRII	NKLER SYSTEM:	NOT PRESENT					
FIRE ALAR	M AND	DETECTION SYSTEM:	PRESENT					
<u>2018 VIRGI</u>	INIA EXI	STING BUILDING CODE						
CHAPTER	3 (VEBC	C): GENERAL PROVISIO	NS AND SPECIAL DETAILED REQUIREMENTS					
SECTION	301.3.2	2 NEW WORK TO BE DO	ONE UNDER WORK AREA COMPLIANCE METHOD.					
SECTION	302.1	NEW AND REPLACEMENT MATERIALS PERMITTED BY THE CODE FOR NEW CONSTRUCTION SHALL BE USED. LIKE OR REPLACEMENT MATERIAL IN COMPLIANCE WITH REQUIREMENTS OR APPROVALS IN EFFECT AT THE TIME OF THEIR ERECTION OR INSTALLATION SHALL BE PERMITTED UNLESS THE BUILDING OFFICIAL DEEMS THEM UNSAFE AND PROVIDE NO HAZARD TO LIFE, HEALTH OR PROPERTY.						
CHAPTER	4 (VEBC	C): ACCESSIBILITY						
SECTION	404		RENOVATIONS IN THIS WORK AREA DO NOT REDUCE OR HAVE THE EFFECT OF ILITY OF THE FACILITY OR PORTION OF THE FACILITY.					
CHAPTER	<u>6 (VEBC</u>	C): ALTERATIONS						
SECTION	602	LEVEL 1 ALTERATION	8					
SECTION	602.2	ALL ALTERATIONS SH PROTECTION AND ME	ALL BE DONE IN A MANNER THAT MAINTAINS THE EXISTING LEVEL OF FIRE ANS OF EGRESS.					
SECTION	602.3. <sup>2</sup>	======	D INTERIOR FINISH AND TRIM MATERIALS SHALL COMPLY WITH CHAPTER 8 OF SCHEDULE, MATERIAL FINISH NOTES.					
SECTION	603	LEVEL 2 ALTERATION	S					
SECTION	603.3	ALL LEVEL 2 ALTERAT	IONS SHALL COMPLY WITH LEVEL 1 ALTERATION REQUIREMENTS.					
SECTION	603.4.3	3 ALL NEW INTERIOR FI	NISH MATERIALS ARE DESIGNED TO COMPLY WITH THE VCC.					
SECTION	603.5	MECHANICAL - WORK CONSTRUCTION COD	AND MATERIALS SHALL BE IN COMPLIANCE WITH THE 2018 VIRGINIA E					
SECTION	603.6	PLUMBING - THE OCC TO REMAIN UNCHANG	UPANT LOAD IS NOT INCREASED MORE THAN 20%. EXISTING FIXTURE COUNT GED.					
CHAPTER	7 (VEBC	C): CHANGE OF OCCUP	ANCY					

NO CHANGE OF OCCUPANCY TO OCCUR.


CHAPTER 12 (VEBC): CONSTRUCTION SAFEGUARDS

CONTRACTOR SHALL COMPLY WITH THE 2018 VIRGINIA CONSTRUCTION CODE



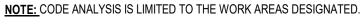



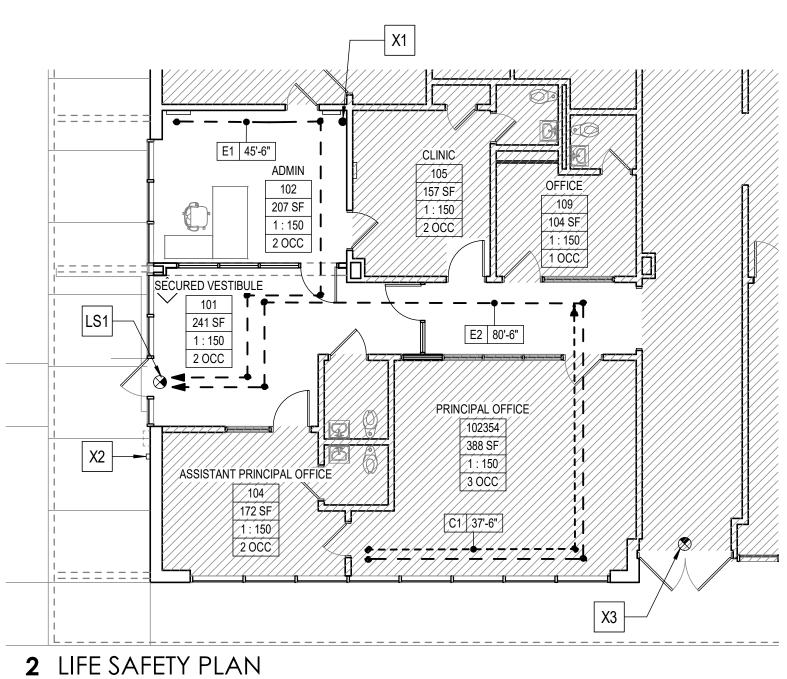

**A041** SCALE: 1/8" = 1'-0" REF: A101

### DEMOLITION OF HAZARDOUS MATERIALS

ASBESTOS AND LEAD DISCLOSURE STATEMENTS AN ASBESTOS INSPECTION HAS BEEN PERFORMED. CONTRACTOR TO OBTAIN INSPECTION REPORT FROM OWNER. CONTRACTOR SHALL ASSUME THERE IS NO ASBESTOS CONTAINING MATERIALS WITHIN THE AREA OF WORK. SHOULD THE CONTRACTOR DISCOVER ANY QUESTIONABLE MATERIAL DURING DEMOLITION/RENOVATION, CONTRACTOR SHALL STOP WORK, AND INFORM OWNER TO OBTAIN CLEARANCE PRIOR TO CONTINUATION OF WORK.

LEAD DISCLOSURE STATEMENT AN INSPECTION TO IDENTIFY LEAD CONTAINING OR COATED BUILDING COMPONENTS HAS BEEN PERFORMED. INSPECTION REPORT IS AVAILABLE FROM OWNER. THIS REPORT IS AVAILABLE FOR THE CONTRACTOR'S USE AND MAY NOT BE ALL INCLUSIVE. IT IS THE CONTRACTOR'S RESPONSIBILITY TO COMPLY WITH ALL VIRGINIA OCCUPATIONAL SAFETY AND HEALTH (VOSH) REGULATIONS AS THEY PERTAIN TO EMPLOYEE

EXPOSURES TO LEAD.

- DEMOLITION GENERAL NOTES
- GN-1: REMOVE WALLS AND OTHER ELEMENTS SHOWN DASHED IN THEIR ENTIRETY. GN-2: CONTRACTOR SHALL REMOVE / DISPOSE OF ANY AND ALL DEMOLITION DEBRIS PROPERLY AND IN ITS ENTIRETY TAKING CARE
- TO KEEP A CLEAN AND SAFE WORKING ENVIRONMENT AT ALL TIMES. GN-3: CONTRACTOR TO ENSURE WORK IS DONE IN A COMPETENT / SAFE MANNER TAKING CARE NOT TO DAMAGE OR DISTURB
- SURROUNDING SURFACES MORE THAN REQUIRED TO COMPLETE DEMOLITION. GN-4: CONTRACTOR SHALL REMOVE EXISTING TRIM AS REQUIRED TO
- COMPLETE WORK IN DESIGNATED AREAS. STORE IN A SAFE, SECURE, DRY AREA UNTIL ITEMS ARE TO BE REINSTALLED. GN-5: CONTRACTOR SHALL REPAIR / PREP / PRIME AND PAINT AREAS
- AND ADJACENT SURFACES DAMAGED OR DISTURBED BY CONSTRUCTION. MATCH ADJACENT WALL COLOR, FINISH AND TEXTURE.
- GN-6: CONTRACTOR TO TEMPORARILY ENCLOSE / SECURE AREAS IN EXTERIOR WALLS LEFT EXPOSED DUE TO DEMOLITION / CONSTRUCTION. ENCLOSURE(S) SHALL BE CONSTRUCTED IN A MANNER WHICH PROTECTS THE EXISTING BUILDING / STRUCTURE / FINISHES ETC. FROM EXPOSURE TO THE ELEMENTS AND PROVIDES A SECURE BARRIER PREVENTING ENTRY OR THEFT DURING CONSTRUCTION.


### **DEMOLITION KEYNOTES**

- A1: REMOVE PORTION OF EXISTING CMU WALL TO ALLOW FOR THE INSTALLATION OF NEW DOOR AND FRAME. CUT ALONG MORTAR JOINTS AT HALF & FULL BLOCK INCREMENTS. A2: REMOVE EXISTING STOREFRONT SYSTEM INCLUDING INTERIOR
- VESTIBULE DOOR AND ALL ASSOCIATED HARDWARE. A3: REMOVE EXISTING AI-PHONE. SALVAGE & RELOCATE TO
- EXTERIOR-SEE AND FOR NEW LOCATION. A4: REMOVE & RELOCATE EXISTING PLAQUE. PATCH & REPAIR WALL AS REQUIRED. COORDINATE NEW LOCATION WITH OWNER.
- E1: REMOVE EXISTING LIGHTS, EXIT LIGHTS & SWITCHES IN AREA OF WORK. PROTECT EXISTING CIRCUITRY - JUNCTION BOXES, CONDUIT AND WIRING ARE TO BE REUSED IF SUITABLE TO CIRCUIT NEW LIGHTS, SEE ELECTRICAL DEMOLITION DRAWINGS.
- E2: RELOCATE EXISTING SECURITY CAMERA. COORDINATE FINAL LOCATION WITH OWNER. REMOVE EXISTING CARPET AND ASSOCIATED ADHESIVE, GLUE, ETC. TO CLEAN AND BARE CONCRETE FLOOR OR SUBFLOOR. COORDINATE FLOORING DEMOLITION WITH NEW LVT LOCATIONS
- AT NEW TRANSITION STRIP SEE FLOOR PLAN ON SHEET A101. F2: REMOVE EXISTING VINYL WALL BASE.
- F3: REMOVE EXISTING MAILBOXES. SALVAGE AND RETURN TO OWNER. LINTEL ABOVE MAILBOXES IS TO REMAIN.
- F4: REMOVE EXISTING TILE AND ASSOCIATED ADHESIVE, GLUE, ETC. TO CLEAN AND BARE CONCRETE FLOOR OR SUBFLOOR.
- F5: REMOVE EXISTING TILE WALL BASE.
- G1. REMOVE EXISTING DOOR AND ALL ASSOCIATED HARDWARE. EXISTING FRAME IS TO REMAIN.
- G2: REMOVE EXISTING DOOR (HM FRAME IS TO REMAIN).
- G3: REMOVE PORTION OF HM GLAZING (THIS SECTION ONLY).

LIFE SAFETY	' LEGEND	
ROOM NAME           RM 101           200 SF           1:200           200 OCC	LIFE SAFETY TAG -ROOM NUMBER -AREA OF SPACE -SF PER OCCUPANT -OCCUPANCY LOAD	
ROOM NAME	ROOM TAG -ROOM NUMBER	
TRAVEL DISTANC	E	
Cx 00'-0"	COMMON PATH OF TRAVEL (Cx) DISTANCE AND DIRECTION	
Ex 00'-0" <100− -	EXIT ACCESS TRAVEL (Ex) DISTANCE AND DIRECTION	
	-CUMULATIVE EGRESS LOAD ALONG PATH	
	PATH OF TRAVEL	
330 200-	<u>EGRESS TAG</u> -ALLOWABLE EGRESS CAPACITY -ACTUAL EGRESS LOAD	

### **LIFE SAFETY PLAN KEYNOTES**

- LS1: PROVIDE NEW EXIT SIGNS.
- X1: EXISTING FIRE EXTINGUISHER LOCATION.
- X2: NEW LOCATION FOR EXISTING KNOX BOX. KNOX BOX IS TO BE SHIFTED TO ACCOMODATE A-I PHONE LCOATION.
- X3: EXISTING EXIT LIGHT TO REMAIN.

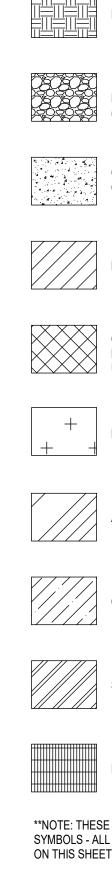

MATERIALS	LEGEND

EARTH	FINISH WOOD
POROUS FILL (STONE OR GRAVEL)	HARDBOARD
CAST-IN-PLACE CONCRETE	SAND, CEMENT, GROUT
BRICK	RIGID INSULATION
CONCRETE MASONRY UNITS	PLYWOOD
MARBLE / GRANITE	GYPSUM WALL BOARD
ALUMINUM	GLASS
OTHER METALS	BRICK VENEER (ELEVATIONS)
STEEL	CMU VENEER (ELEVATIONS)
EXPANSION JOINT	BATT INSULATION
E ARE STANDARD LL SYMBOLS NOTED ET MAY NOT APPLY.	WOOD BLOCKING

SYMBOLS LEG	GEND
<u>VIEW TITLE</u>	VIEW NUMBER VIEW TITLE SCALE: 1/8" = 1'-0" REF: R101
BUILDING SECTION TAG	DRAWING SCALE SHEET REFERENCE
N WALL SECTION TAG	DRAWING NUMBER
DETAIL SECTION TAG	DRAWING NUMBER
ENLARGED DETAIL	DRAWING NUMBER
EXTERIOR ELEVATION TAG	DRAWING NUMBER
INTERIOR ELEVATION TAG	5F/ A101 - DRAWING / SHEET NUMBER
ROOM TAG	ROOM NAME
<u>LIFE SAFETY TAG</u>	ROOM NAME RM 101 - ROOM NUMBER 200 SF - ROOM AREA 1 : 200 - OCCUPANT PER SF RATIO 200 OCC - OCCUPANCY LOAD
PARTITION TAG	A2B1 FIRE RATING (HOURS) PARTITION STRUCTURE PARTITION STRUCTURE SIZE (NOMINAL) PARTITION TYPE (SCHEDULE)
DOOR NUMBER	101A
SIGNAGE TAG	■ 101A
EGRESS TAGS	ALLOWABLE EGRESS CAPACITY OF OPENING
	ACTUAL EGRESS LOAD OF OPENING
	30 - CUMULATIVE EGRESS LOAD ALONG PATH
<u>STOREFRONT / WINDOW /</u> CURTAINWALL FRAMING	FRAME TYPE
GLASS TYPE	GL-#
COLUMN GRID LINE NEW CONSTRUCTION	A DESIGNATOR
<u>CASEWORK TAG</u> * "M" = MODIFIED ** "V" = VARIES, MA WIDTH OF ADJACE CASEWORK BELOV	NT NT
DEMOLITION NOTE	$\langle D1 \rangle$ $\langle L1 \rangle$
TOILET ACCESSORIES	(TA1)
EQUIPMENT NUMBER	(EQ1)
REVISION NUMBER	<b>/#</b>
NORTH DIRECTION	
MATCHLINE	
CENTERLINE	
LIMITS OF CONSTRUCTION	L.O.C.
STAIR DIRECTION	←> UP / DN
BREAKLINE	\
SPOT ELEVATION	1226'-0"
BENCHMARK ELEVATION	XXX LEVEL XX' - XX"

**KEYNOTE INDICATOR** 

A - ARCHITECTURAL / GENERAL C - CIVIL E - ELECTRICAL F - FINISHES / FURNITURE G - GLAZING / DOORS LS - LIFE SAFETY

LOC

LLV LONG LEG VERTICAL

LIMITS OF

LP LOW POINT

CONSTRUCTION

M - MECHANICAL P - PLUMBING R - ROOF S - STRUCTURAL W - WALLS X - EXISTING


NOTES: 1. INDICATOR LETTER IS USED FOR KEYNOTE ORGANIZATION ONLY AND IS NOT INTENDED TO ASSIGN OR EXCLUDE WORK AND/OR COORDINATION TO OR FROM SPECIFIC TRADES OR DISCIPLINES

2. KEYNOTES ARE TYPICALLY ASSOCIATED WITH A DRAWING SERIES. KEYNOTE NUMBERS MAY VARY FROM SERIES TO SERIES. SOME KEYNOTES MAY APPEAR IN A SHEET'S LEGEND, BUT NOT APPEAR IN A DRAWING ON THAT SPECIFIC SHEET.

ARCHITECTURAL ABBREVIATIONS

AB	ANCHOR BOLT	MACH	MACHINE
ACM	ALUMINUM	MAINT	MAINTENANCE
	COMPOSITE	MATL	MATERIAL
	MATERIAL	MECH	MECHANICAL
ACP		MO	MASONRY OPENING
	CEILING PANEL	MTL	METAL
AFF	ABOVE FINISH FLOOR		
ALT	ALTERNATE	NA	NOT APPLICABLE
		NIC	NOT IN CONTRACT
ALUM	ALUMINUM	NTS	NOT TO SCALE
ARCH	ARCHITECTURAL	NT5	NOT TO SCALL
BD	BOARD	OC	ON CENTER
BLDG	BUILDING	OD	OUTSIDE DIAMETER
BLKG		OH	OPPOSITE HAND
BOT	BLOCKING	OIT	OFFOOTETIN
BRG	BOTTOM	PLAM	PLASTIC LAMINATE
BRG	BEARING	PLUMB	PLUMBING
		PLOMB	PAINTED
CI	CONTINUOUS INSULATION	PNI PT	PRESERVATIVE
<u></u>		PI	TREATED
CJ	CONTROL JOINT		
CLG	CEILING	R	
CMU			RADIUS
0010	MASONRY UNIT	RCP	REFLECTED CEILING PLAN
CONC	CONCRETE	RE	
CONF	CONFERENCE		REFER
CONT	CONTINUOUS	RECPT	RECEPTION
CONTR	CONTRACTOR	REINF	REINFORCEMENT
CW	CASEWORK	REV	REVERSED
		RM	ROOM
DIA	DIAMETER	RO	ROUGH OPENING
DS	DOWNSPOUT		
		SCHED	SCHEDULE
EA	EACH	SHT	SHEET
EB	EXPANSION BOLT	SPEC	SPECIFICATION
EF	EACH FACE	SS	STAINLESS STEEL
EJ	EXPANSION JOINT	STL	STEEL
EL	ELEVATION	STOR	STORAGE
ELEC	ELECTRICAL	STRUCT	STRUCTURAL
ELEV	ELEVATION		
ELEV	ELEVATOR	THRESH	THRESHOLD
EQ	EQUAL	TLT	TOILET
EQUIP	EQUIPMENT	TOJ	TOP OF JOIST
		TOS	TOP OF STEEL
EW	EACH WAY	TOW	TOP OF WALL
EXIST	EXISTING	TYP	TYPICAL
EXT	EXTERIOR	LIE	TIFICAL
FLR	FLOOR	UNO	UNLESS NOTED
FRT	FIRE RETARDANT	0110	OTHERWISE
FRI	TREATED	UR	URINAL
FSM	FLEXIBLE SHEET	U.Y.	
FOIVI	MEMBRANE	VEST	VESTIBULE
	ROOFING	VEOT	VEGNDOLL
FTG	FOOTING	W/	WITH
		W/O	WITHOUT
GALV	GALVANIZED	W/O WC	WATER CLOSET
GN	GENERAL NOTE	WD	WOOD
GYB	GYPSUM WALL		WHEELCHAIR
010	BOARD		WHEELCHAIR
GYP	GYPSUM WALL	0	DEGREE
	BOARD		PLUS / MINUS
		±	DIAMETER
HDWRE	HARDWARE	Ø	
HGT	HEIGHT	≤	LESS THAN OR EQUAL TO
HIPAC	HIGH	≥	GREATER THAN OR
	PERFORMANCE	2	EQUAL TO
	ARCH COATING	•	BULLET POINT
HP	HIGH POINT	•	
HR	HOUR		
ID	INSIDE DIAMETER		
INT	INTERIOR		
ISOL	ISOLATION		
JAN	JANITOR		
JT	JOINT		


DEMOLITION LEGEND
EXISTING WALLS TO REMAIN
EXISTING WALLS TO BE REMOVED
EXISTING MISCELLANEOUS ITEMS TO BE REMOVED
EXISTING DOOR TO BE REMAIN
EXISTING DOOR TO BE REMOVED
0 2' 4' 8' SCALE: 1/4" = 1' - 0"

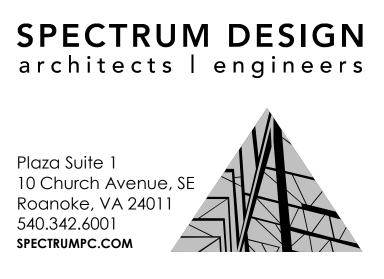


# **RENOVATIONS TO** HURT PARK ELEMENTARY SCHOOL SECURED VESTIBULE **ROANOKE CITY PUBLIC SCHOOLS**

VA DOE NO.: **#**124-42-00-102 SPECTRUM DESIGN PROJECT NO.: 22082 <sup>5</sup>DAVID C. VENABLE Lic. No. 8832 11.04.2022 PROJ. MGR.: CHECKED BY: DRAWN BY: DCV DCV TLW SHEET ISSUE DATE: 11.04.2022 PROJECT PHASE: CONSTRUCTION DOCUMENTS

SHEET REVISIONS: **REV A 03.03.2023 ADDENDUM #1** 

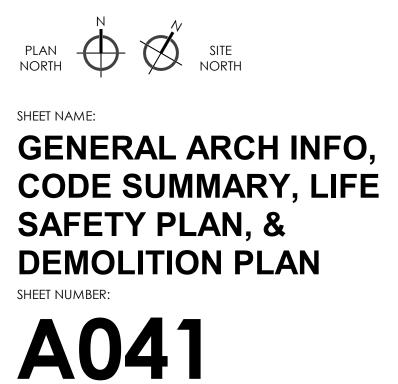




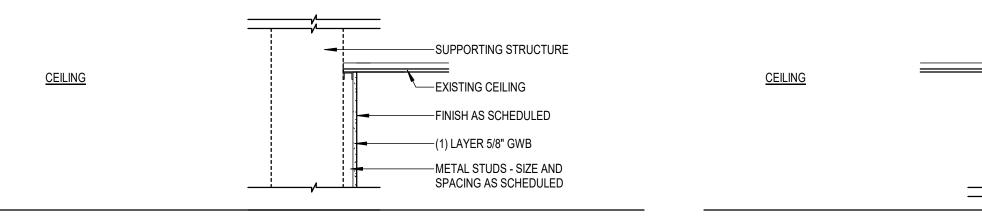

FxB TERMINATION DETAIL


PLAN

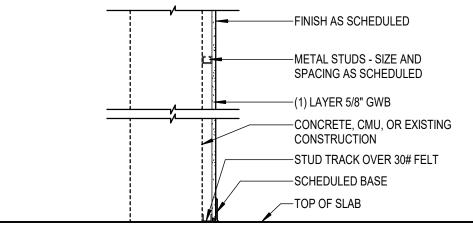

F PARTITION TYPE										
	ASSEMBLY TAG	TOTAL WIDTH	STRUCT. WIDTH	MIN. GAUGE	MAX. Spacing	Limiting Height	UL NO.	FIRE RATING	TERMINATION DETAIL	KEYNOTES
	F3B	3 1/8"	2 1/2"	20	16"	UP TO EXISTING CEILING			FxB	


DOOR AND FRAME SCHEDULE - ALUMINUM													
<b>OPENING NO./</b>		DOOR					FR/	AME	HDWRE				
DOOR MARK	ELEV	PAIR	MATL	WIDTH	HEIGHT	RATING	ELEV	MATL	SET	AO	CR	KEYNOTES	
FIRST FLOOR													
102	SF		ALUM	3' - 0"	6' - 10"		SF	AL	SEE SPECS		•		
103.1	SF		ALUM	3' - 0"	6' - 10"		SF	AL	SEE SPECS		•		


DOOR AND FRAME SCHEDULE											
OPENING NO./		DOOR					FIRE FR/		HDWRE		
DOOR MARK	ELEV	PAIR	MATL	WIDTH	HEIGHT	RATING	ELEV	MATL	SET	CR	KEYNOTES
FIRST FLOOR											
104	NT		WD	3' - 0"	7' - 0"		EXIST	EXIST	SEE SPECS	٠	DOOR IN EXISTING FRAME. PROVIDE DOOR CLOSER
105	F		WD	3' - 0"	6' - 10"		F1	HM	SEE SPECS		
X105	EXIST		EXIST	3' - 0"	6' - 10"		EXIST.	HM	SEE SPECS	•	NEW HARDWARE
X107	EXIST		EXIST	3' - 0"	6' - 10"		EXIST	HM	SEE SPECS	٠	NEW HARDWARE

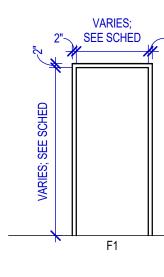


TAG

G4B

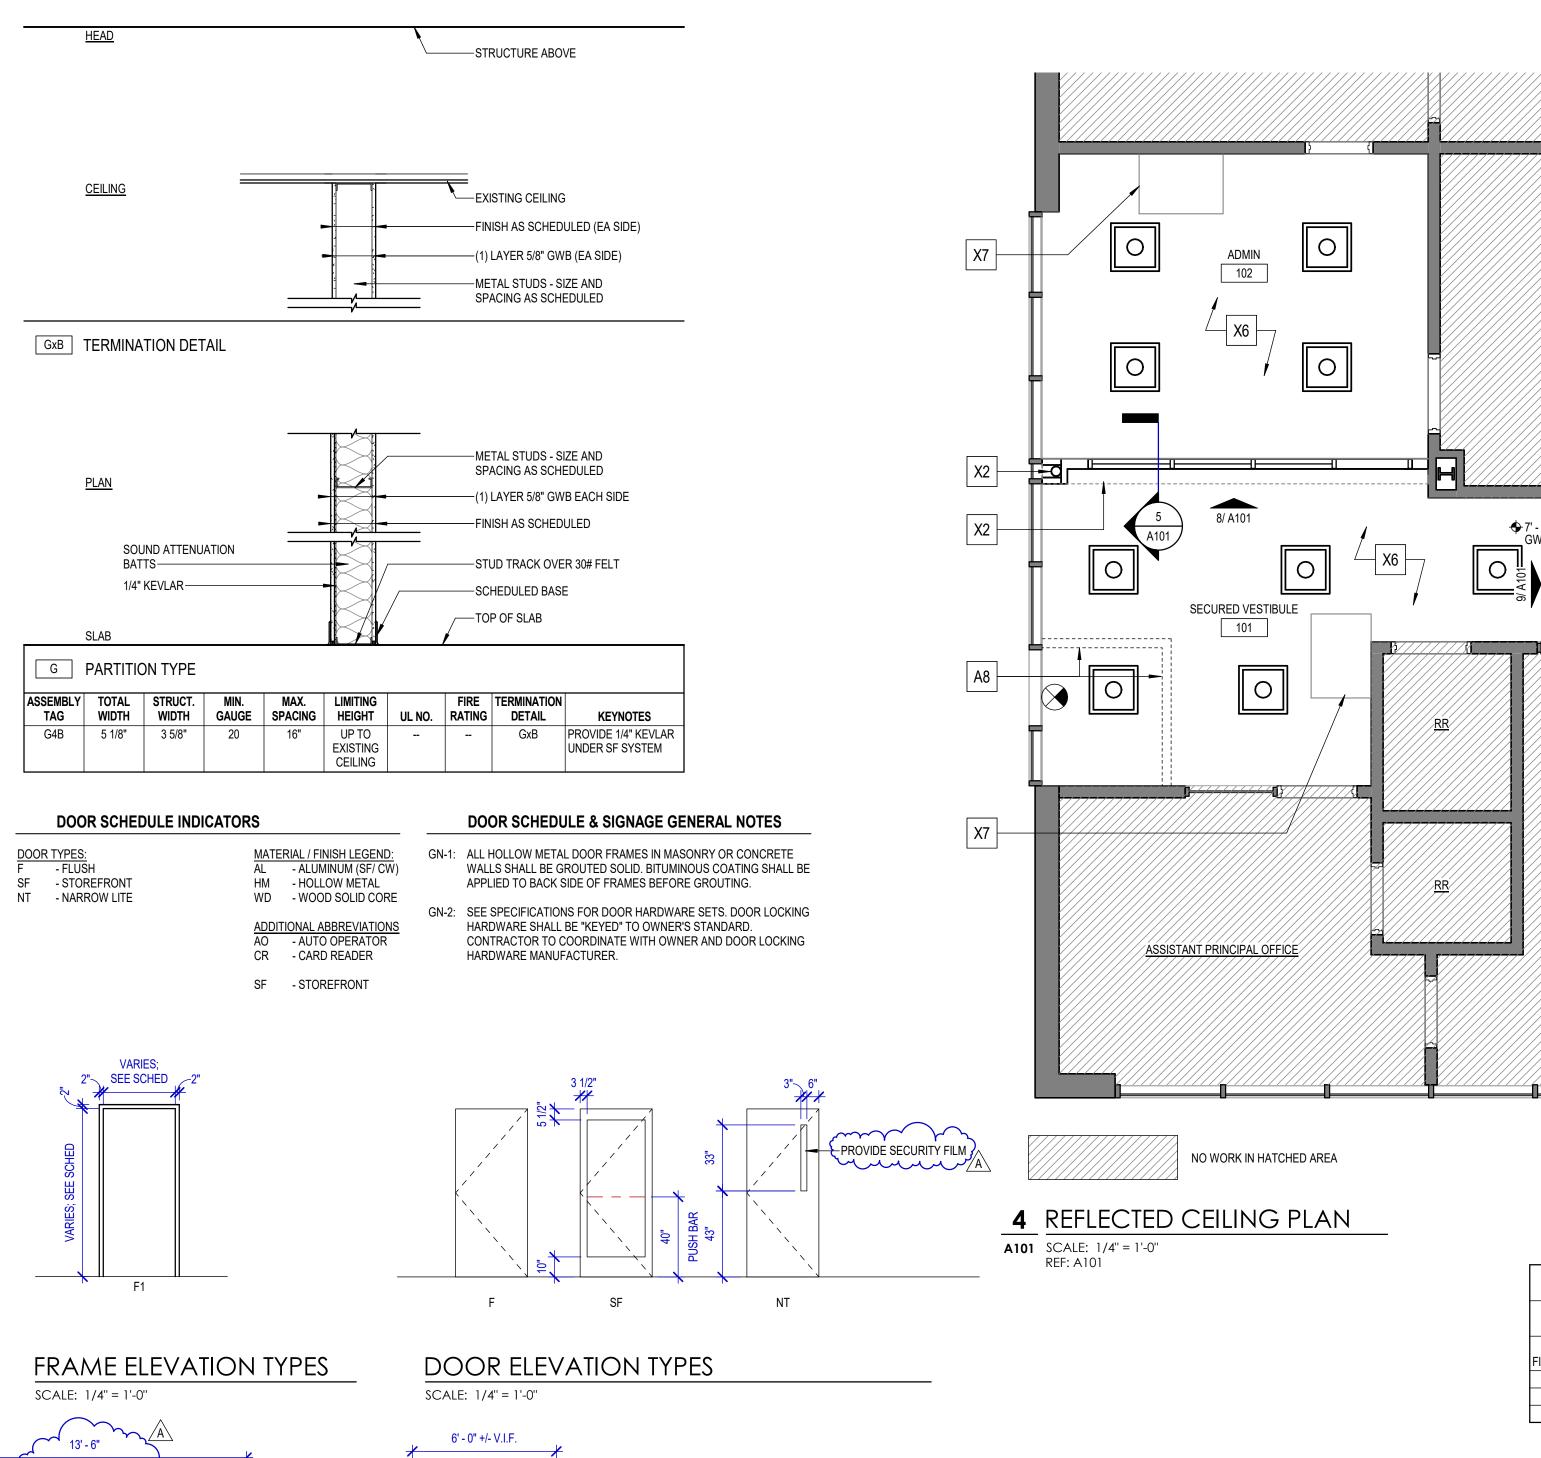


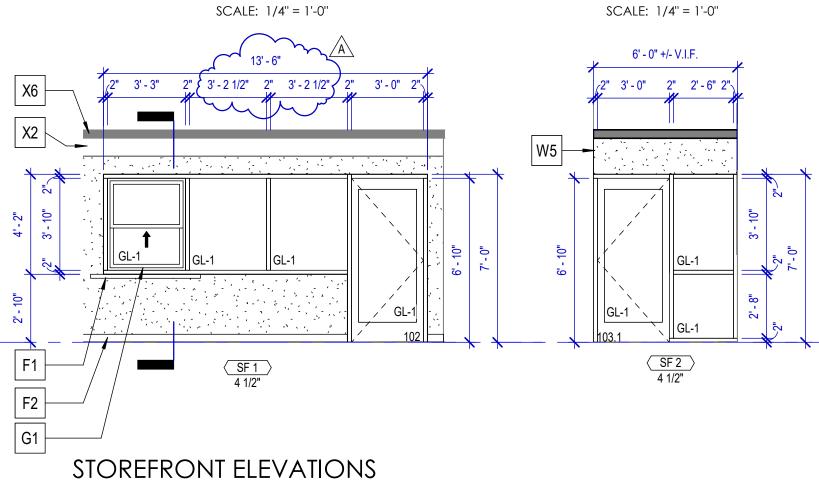

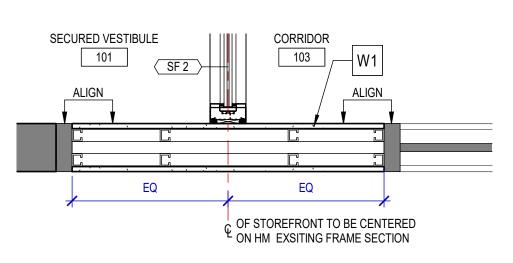

3 PLAN DETAIL **A101** SCALE: 1" = 1'-0" REF: A101

SCALE: 1/4" = 1'-0"

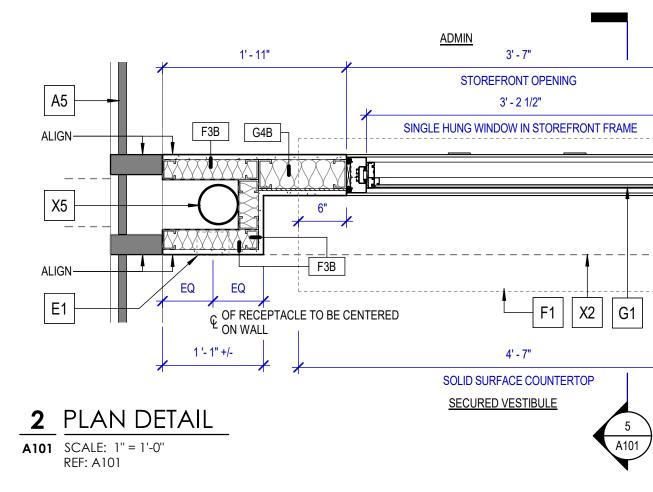

- SF 1

6"

<del>⊀\_\_\_⊀\_\_</del>\_

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A101

				0.0	1 0				SPE
)5	F		WD	3' - 0"	6' - 10"		F1	HM	SE SPE
05	EXIST	1	EXIST	3' - 0"	6' - 10"	-	EXIST.	HM	SE SPE
07	EXIST		EXIST	3' - 0"	6' - 10"		EXIST	HM	SPE




- GN-1: CONTRACTOR TO PROVIDE STOREFRONT MANUFACTURER'S PREFORMED SUB-SILL, BASE FLASHING, AND END DAMS, TYPICAL.
- GN-2: DIMENSIONS SHOWN ARE NOMINAL AND PROVIDED FOR DESIGN INTENT. CONTRACTOR TO FIELD VERIFY ROUGH OPENINGS, AND ACCOUNT FOR JOINTS, SHIMS, SEALANT, ETC.
- GN-3: JOINTS SHOWN IN ELEVATION BETWEEN STOREFRONT MEMBERS
- ARE NOT INTENDED TO SHOW ACTUAL JOINT LOCATIONS.
- GN-4: DEPTH OF STOREFRONT FRAMES TO BE 4 1/2" U.N.O. GN-5: ALL GLAZING IN INTERIOR FRAMES SHALL BE TYPE GL-1, U.N.O.
- GN-6: GLAZE ALL OPENINGS IN FRAMES, U.N.O.
- GN-7: ALL GLAZING SHALL BE SAFETY GLASS, U.N.O.


FRAMED OPENINGS INDICATOR


LVR = LOUVER (SF XX.X) - FRAME NO. HM = HOLLOW METAL XX" - FRAME DEPTH SF = STOREFRONT (INTERIOR) SX = STOREFRONT (EXTERIOR) WN = WINDOW

**GLAZING / PANEL LEGEND** 

GL-1 = 1/4" TEMPERED CLEAR W/ SAFETY FILM

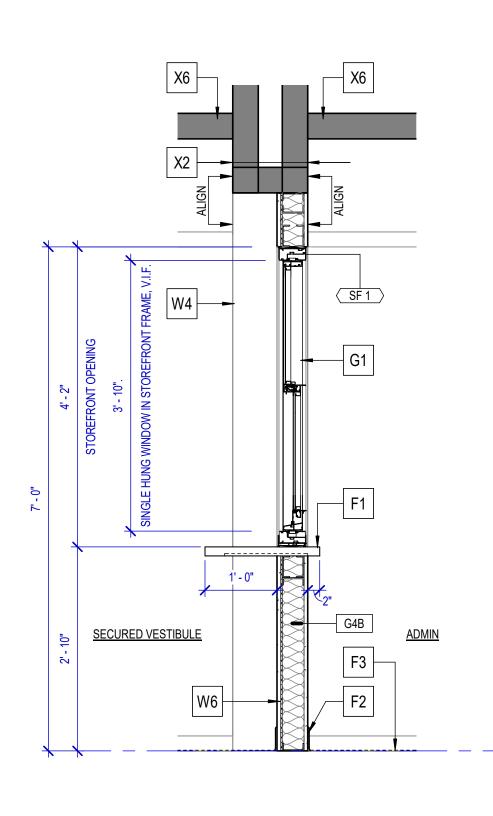

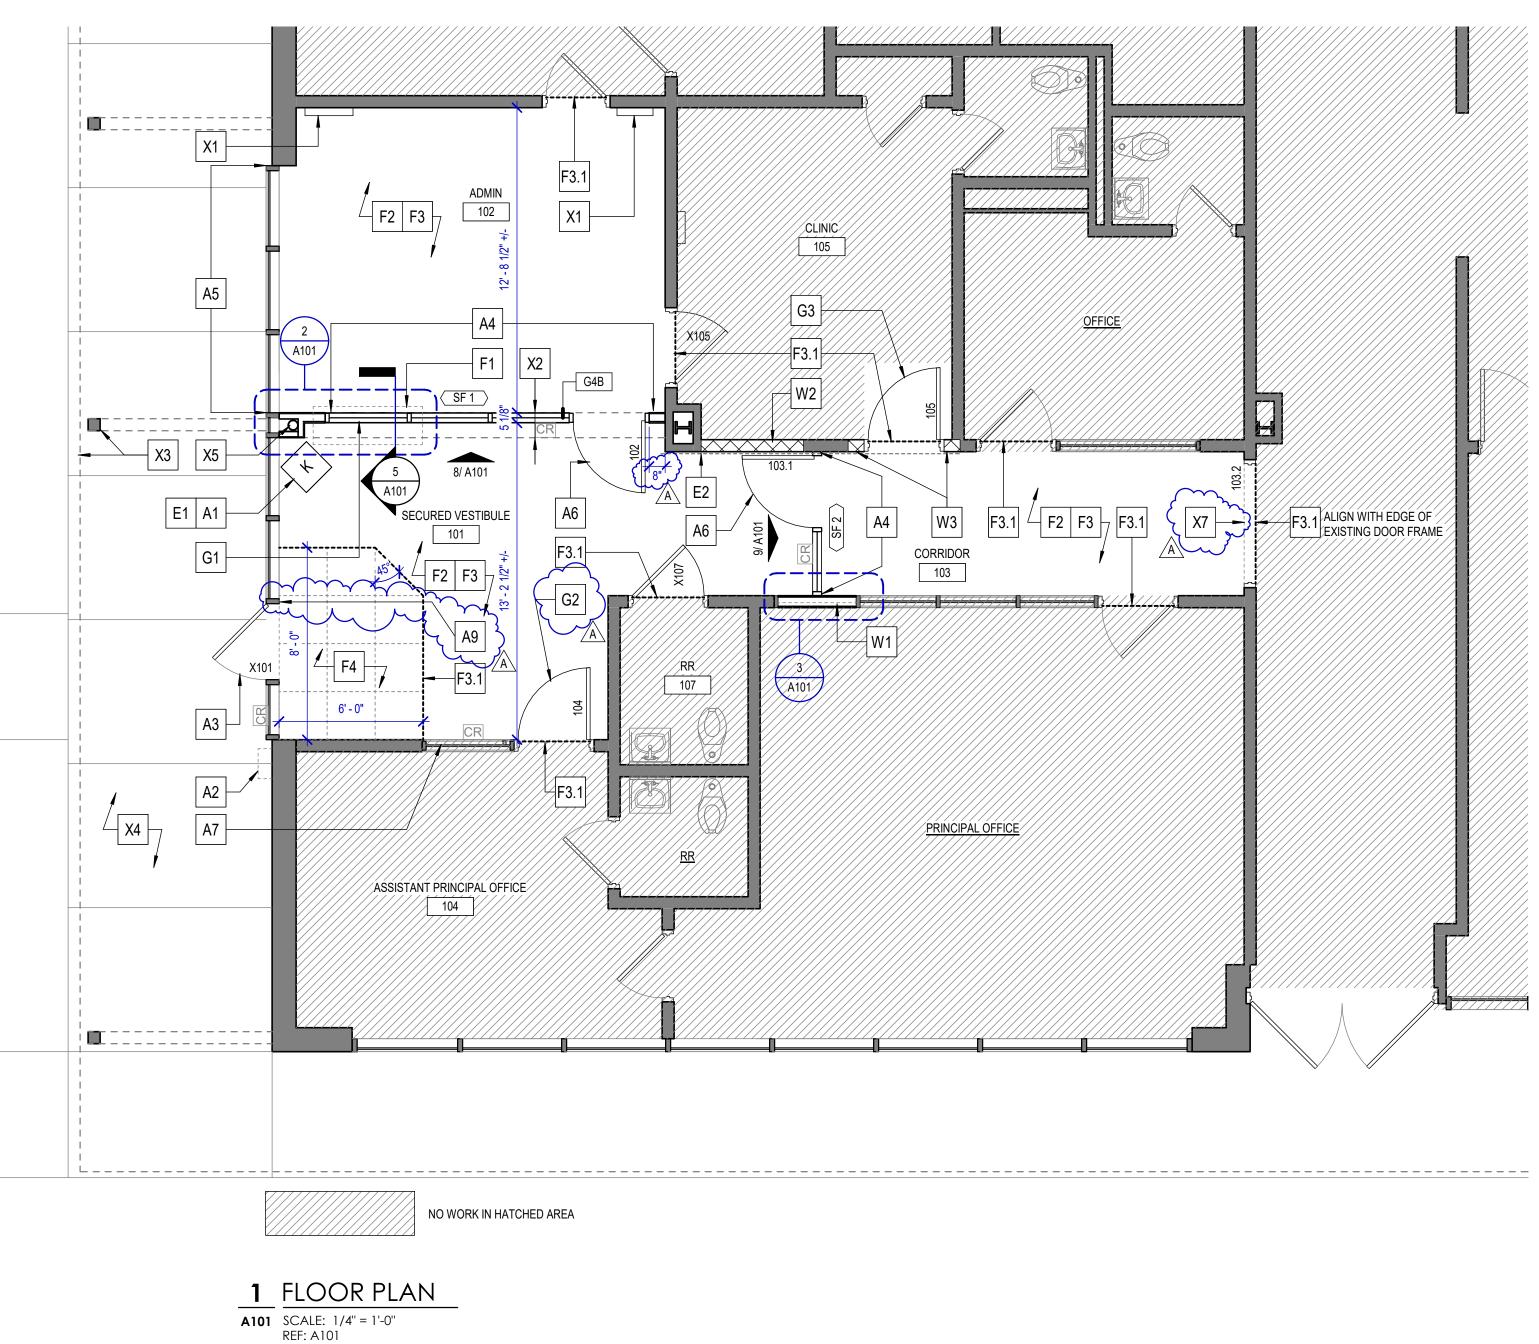

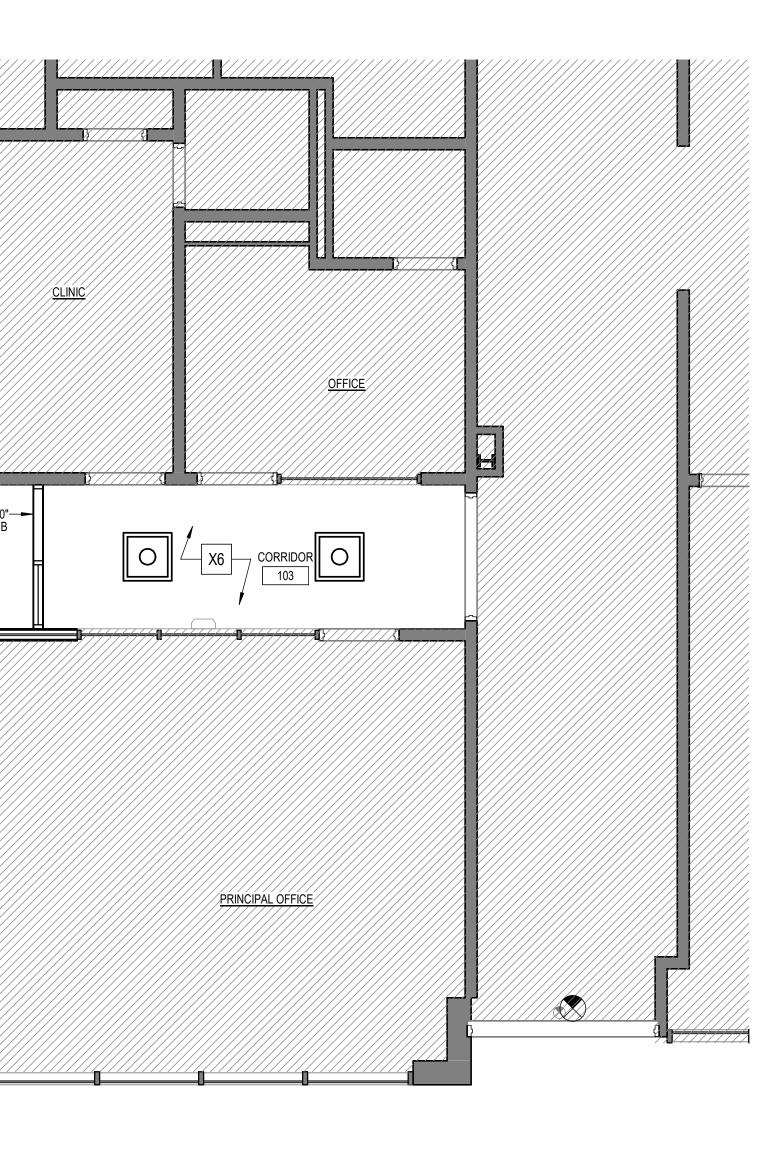


## **ROOM FINISH SCHEDULE**

				WALLS		CEILING			
ROOM NO.	ROOM NAME	FLOOR	BASE	MATL	FINISH	MATL	FINISH	HEIGHT	REMARKS
	·			•					
FIRST FLOOR									
101	SECURED VESTIBULE	LVT/CPT*	VINYL	EXIST/GWB	PNT	EXIST	PNT	8'-6"	*WALKOFF CARPET
102	ADMIN	LVT	VINYL	EXIST/GWB	PNT	EXIST	PNT	8'-6"	
103	CORRIDOR	LVT	VINYL	EXIST/GWB	PNT	EXIST	PNT	8'-6"	

GN-1: DIMENSION GUIDELINES: • NEW CONSTRUCTION = PLAN DIMENSIONS ARE TO FACE OF
FRAMING MEMBERS AT GWB, FACE OF MASONRY, AND CENTERLINE OF STRUCTURAL GRID U.N.O. • EXISTING CONSTRUCTION = PLAN DIMENSIONS ARE TO FACE OF
FINISH OF EXISTING WALLS TO REMAIN U.N.O. • PLUMBING FIXTURES = PLAN DIMENSIONS ARE FROM FACE OF FINISH (GWB, TILE, ETC) TO CENTERLINE OF FIXTURE. • "CLEAR" = DIMENSIONS ARE TO FACE OF FINISH (GWB, TILE, ETC).
GN-2: WHERE PARTITIONS OF DIFFERENT THICKNESSES ABUT OR ADJOIN IN THE SAME LOCATION, THE EXPOSED / FINISH FACES SHALL BE INSTALLED FLUSH / ALIGNED.
GN-3: SEE LIFE SAFETY PLANS FOR FIRE EXTINGUISHER CABINET LOCATIONS.
GN-4: ALL EXISTING & NEW WALLS & CEILINGS IN AREA OF WORK ARE TO BE PAINTED TO MATCH EXISTING.
GN-5: PATCH & REPAIR CEILING WHERE EXISTING 2X4 LIGHT FIXTURES HAVE BEEN REMOVED.
XX       KEYNOTES         A1:       NEW LOCATION FOR EXISTING SECURITY KIOSK - SEE ELECTRICAL
DRAWINGS FOR POWER & DATA REQUIREMENTS. A2: NEW LOCATION FOR EXISTING AI-PHONE - SEE ELECTRICAL
<ul><li>DRAWINGS FOR POWER &amp; DATA REQUIREMENTS.</li><li>A3: PROVIDE NEW ACCESS HARDWARE AT EXISTING STOREFRONT</li></ul>
DOOR TO REMAIN. SEE DOOR SCHEDULE & SPECS - SEE ELECTRICAL DRAWINGS FOR POWER & DATA REQUIREMENTS.
<ul><li>A4: PROVIDE SAFETY FILM AT NEW STOREFRONT SYSTEM.</li><li>A5: PROVIDE SAFETY FILM AT EXISTING STOREFRONT AT ADMIN.</li></ul>
A6: PROVIDE ACCESS HARDWARE AT NEW STOREFRONT DOOR. SEE DOOR SCHEDULE & SPECS - SEE ELECTRICAL DRAWINGS FOR POWER & DATA REQUIREMENTS.
A7: PROVIDE SAFETY FILM AT EXISTING HOLLOW METAL WINDOW TO REMAIN.
A8: PATCH & REPAIR GWB CEILING AS REQUIRED WHERE EXISTING
A9: WHERE EXISTING INTERIOR STOREFRONT VESTIBULE HAS BEEN REMOVED, PROVIDE BRAKE METAL ON THE INSIDE OF THE
EXTERIOR SF MULLION TO CONCEAL EXISTING ATTACHMENT. BRAKE METAL IS TO MATCH EXISTING SF. E1: PROVIDE NEW POWER & DATA FOR EXISTING SECURITY KIOSK SEE ELECTRICAL DRAWINGS.
E2: RELOCATE EXISTING PANDUIT RACEWAY ABOVE NEW STOREFRONT (SF2) & HM FRAME (105).
F1: NEW SOLID SURFACE TRANSACTION COUNTER w/ 2" BUILT UP EDGE. PROVIDE CONCEALED FLAT COUNTERTOP BRACKETS AS REQUIRED. ROUTE BOTTOM OF SOLID SURFACE SO THAT BRACKETS SIT FLISH WITH BOTTOM OF COUNTER SURFACE.
F2: PROVIDE NEW VINYL WALL BASE THROUGHOUT.
<ul><li>F3: PROVIDE NEW LVT THROUGHOUT.</li><li>F3.1: PROVIDE VINYL TRANSITION STRIP WHERE NEW LVT MEETS</li></ul>
EXISTING CARPET, CONCRETE, OR TILE. TRANSITION STRIP IS TO BE LOCATED AT THE CENTERLINE OF THE DOOR LEAF(WHERE APPLICABLE), U.N.O.COORDINATE WITH DEMO PLAN.
F4: PROVIDE NEW WALK-OFF CARPET TILE. ALIGN WITH LVT JOINTS. PROVIDE VINYL & REDUCERS BETWEEN CARPET TILE & LVT.
G1: NEW SINGLE-HUNG TRANSACTION WINDOW W/ SAFETY FILM IN ALUMINUM STOREFRONT FRAME. SEE STOREFRONT ELEVATIONS.
G2: PROVIDE NEW DOOR IN EXISTING HOLLOW METAL FRAME.
<ul> <li>G3: PROVIDE NEW DOOR INTO CLINIC.</li> <li>W1: PROVIDE WALL INFILL WHERE GLAZING HAS BEEN REMOVED IN HOLLOW METAL FRAME WINDOW SYSTEM (THIS SECTION ONLY - REST OF HOLLOW METAL FRAME TO REMAIN.) INFILL WITH 5/8" GWB ON METAL STUDS AS REQUIRED. GWB IS TO BE FLUSH WITH EXISTING HOLLOW METAL FRAME.</li> </ul>
W2: PROVIDE WALL INFILL IN KIND WHERE MAILBOXES HAVE BEEN REMOVED.
W3: TOOTH-IN CMU W/ HALF & FULL BLOCKS, GROUT OPEN CELLS.
<ul><li>W4: GWB WALL BEYOND.</li><li>W5: NEW GWB BULKHEAD ABOVE NEW STOREFRONT SYSTEM, PAINT.</li></ul>
W6: 1/4" KEVLAR UP TO BOTTOM BOTTOM OF STOREFRONT SYSTEM.
X1: EXISTING ELECTRICAL EQUIPMENT TO REMAIN.
<ul><li>X2: EXISTING BULKHEAD ABOVE TO REMAIN.</li><li>X3: EXISTING CANOPY &amp; CANOPY STRUCTURE TO REMAIN.</li></ul>
X4: EXISTING CONCRETE WALKWAY TO REMAIN.
X5: EXISTING STRUCTURE TO REMAIN.
X7: EXISTING FRAME TO REMAIN. PATCH & REPAIR FRAME WITH HINGE FILLER WHERE EXIST. DOOR & HARDWARE HAVE BEEN REMOVED -
X8: EXISTING CEILING MOUNTED MINI-SPLIT SYSTEM TO REMAIN.
REFLECTED CEILING PLAN LEGEND
EXISTING GWB CEILING - PAINTED
O 2X2 LIGHT FIXTURE, RE: ELEC
EXIT SIGN, RE: ELEC
FLOOR PLAN WALL LEGEND           EXISTING WALLS TO REMAIN
NEW WALLS TO BE CONSTRUCTED
EXISTING DOOR
MINIMUM DOOR CLEARANCE LEGEND
PARTITION WHERE OCCURS
PARTITION WHERE OCCURS - PULL SIDE 6" (TYP.) - PARTITION WHERE OCCURS
ANSI 117.1 2009 / ADASAD 2010 FIG. 404.2.3.2 (A) (B) WHERE LATCH SIDE OF DOORWAYS ARE LOCATED AD JACENT TO A

ANSI 117.1 2009 / ADASAD 2010 FIG. 404.2.3.2 (A) (B) WHERE <u>LATCH</u> SIDE OF DOORWAYS ARE LOCATED ADJACENT TO A PERPENDICULAR PARTITION AND NOT OTHERWISE DIMENSIONED: • <u>PUSH SIDE</u> - PROVIDE 1'-0" MIN. CLEAR BETWEEN <u>INSIDE</u> EDGE OF FRAME OPENING AND FINISH FACE OF ADJACENT PARTITION. • <u>PULL SIDE</u> - PROVIDE 1'-6" MIN. CLEAR BETWEEN <u>INSIDE</u> EDGE OF FRAME OPENING AND FINISH FACE OF ADJACENT PARTITION. SCALE: 1/4" = 1' - 0"

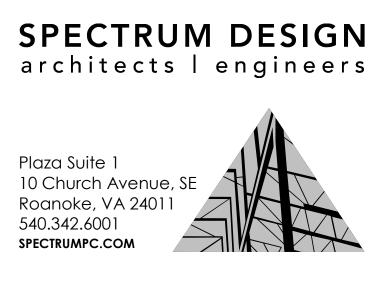

# **RENOVATIONS TO** HURT PARK **ELEMENTARY SCHOOL** SECURED VESTIBULE **ROANOKE CITY PUBLIC SCHOOLS**

**#**124-42-00-102

SPECTRUM DESIGN PROJECT NO.: 22082 <sup>5</sup>DAVID C. VENABLE Lic. No. 8832 11.04.2022 PROJ. MGR.: CHECKED BY: DRAWN BY: DCV DCV TLW SHEET ISSUE DATE: 11.04.2022 PROJECT PHASE:

CONSTRUCTION DOCUMENTS SHEET REVISIONS:

**REV A 03.03.2023 ADDENDUM #1** 


KEY PLAN:

SHEET NUMBER:


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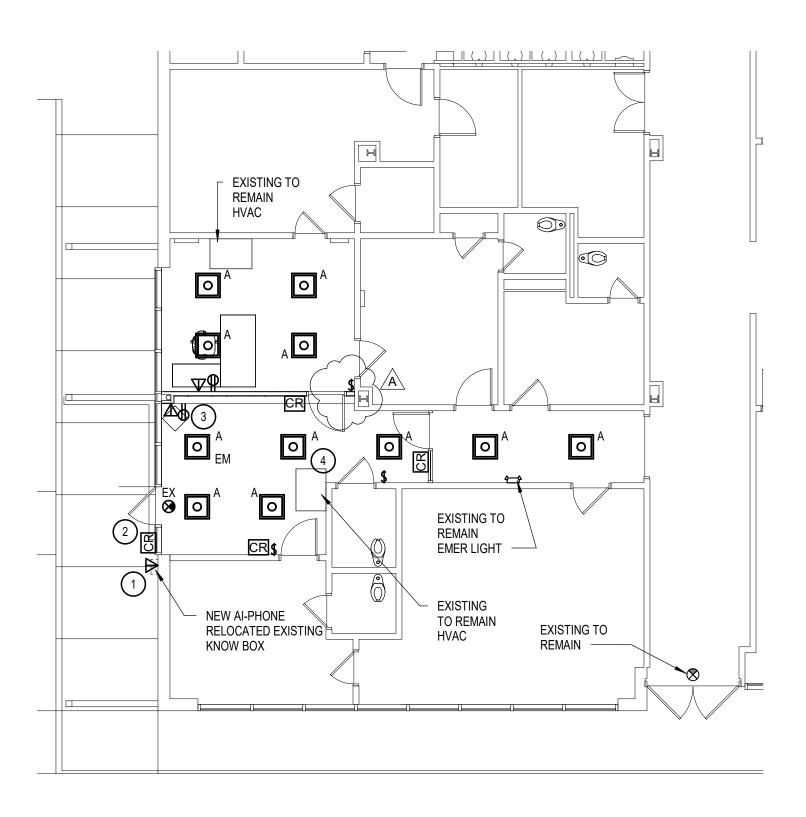
VA DOE NO.:

╷┝┥┢┥ AREA OF WORK NORTH Sheet name: FLOOR PLAN, RCP, **PARTITION TYPES, DETAILS, SF ELEVS & DOOR SCHEDS** 

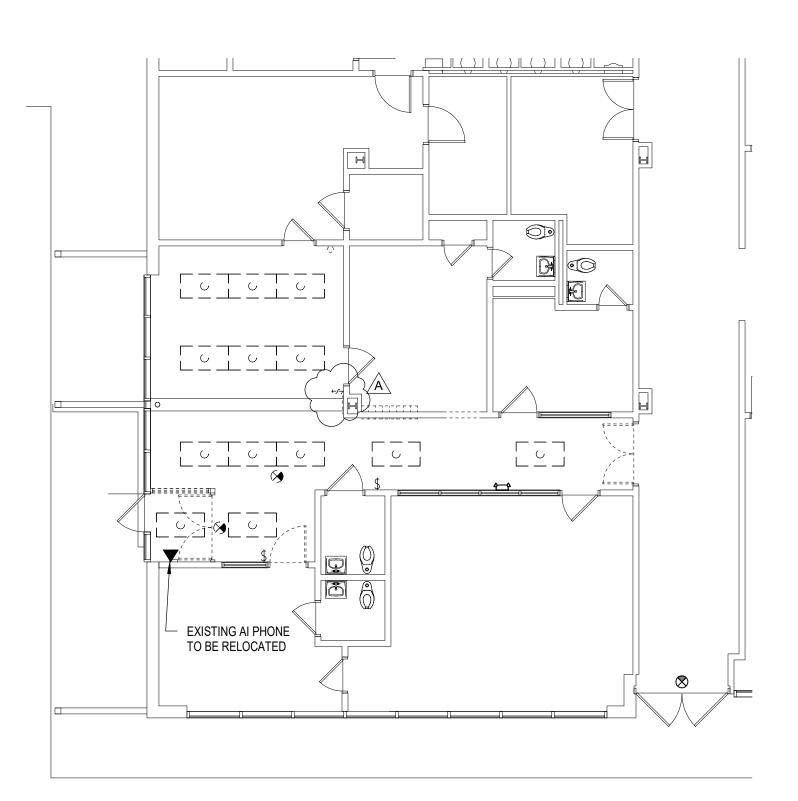

## 1 DEMOLITION - FLOOR PLAN



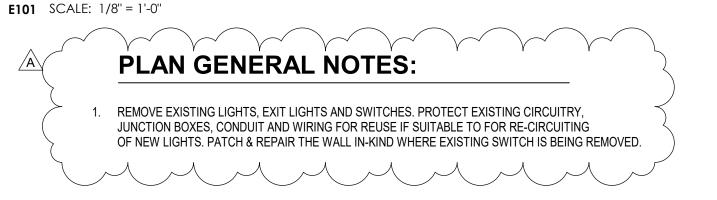


### 2 FLOOR PLAN **E101** SCALE: 1/8" = 1'-0"

### **PLAN KEYNOTES:**

- 1. PROVIDE DATA OUTLET FOR EXISTING AI-PHONE. PROVIDE 1" CONDUIT TO EXISTING SECURITY SYSTEM.
- 2. CARD READER MOUNTS TO DOOR MULLION. PROVIDE CONNECTION TO EXISTING SECURITY SYSTEM. SEE TYPICAL FOR ALL CARD READERS. 3. PROVIDE POWER AND DATA OUTLETS FOR NEW SECURITY KIOSK. PROVIDE NEMA 5-20 RECEPTACLE AND DATA OUTLET WITH 2 CAT6A GREEN CABLES APRROX. 200' LONG. CIRCUIT RECEPTACLE TO NEAREST AVAILABLE 20A, 120V PANELBOARD CIRCUIT. COORDINATE WITH ARCHITECTURAL SHEET A101 FOR EXACT LOCATION.
- 4. CIRCUIT LIGHTS WITH EXISTING LIGHTING CIRCUITRY.

			LIGHTING FIXTURE SC	HEDULE			
MARK	DESCRIPTION	MANUFACTURER	MODEL	LAMP	COLOR TEMPERATURE	WATTS	MOUN
А	2 X 2 SHALLOW SURFACE MOUNT WITH RIBBED ACRYLIC ROUNDED SHIELDING	LITHONIA	PTS 2 2 L38 35 RA UNV OPTIONS (EM/10W ONLY WHERE EM INDICATED)	LED	3500 K	31 W	SURF/
EX	UNIVERSAL MOUNT EXIT SIGN	LITHONIA LIGHTING	EDG_R W 1 R EL	LED			SURFA

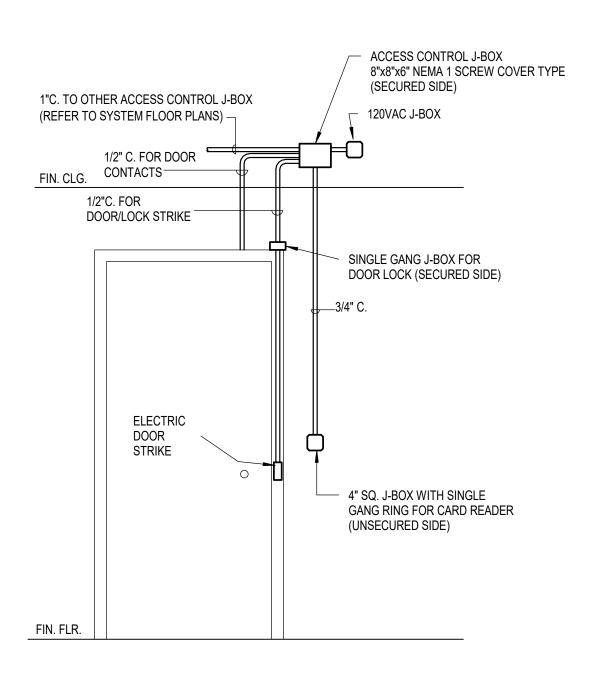

DETAIL - ACCESS CONTROL CONDUIT DETAIL FOR CARD READER 3 SYSTEM

**E101** SCALE: 6" = 1'-0"

LE	GEND/SYMBOI	LS - SI
POV	VER	
	φ	DUF
DAT		
	•	AI P
SEC	URITY/ACCES	S CON
	CR	CA
LIGH	IT FIXTURES	
	0	2X2
[	0	2X4
	<b>(3)</b>	EX
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SWI	TCH AND CON	TROL
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•	$\langle 1 \rangle$	NUMB
GEN	IERAL DEMOLI	
1.	THE ELECTRI	CAL D
	INVASIVE VIS VISIT THE SIT	UAL IN
	DOCUMENTS. CONDITIONS	
2.	JUNCTION BC	
	DEVICES SCH JUNCTION BC FOR DEVICES	X OR
	BETWEEN TH SPARE, SHUT	EM AN
2.	EXERCISE CA	
	DAMAGE CAU	
3.	IF SUSPECTE NOT DISTURE OR OTHERWI	. IMME
	BE HANDLED	AND T
	DISPOSED OF FEDERAL GUI	OR R
	BUT ARE NOT TUBES, POTE	NTIAL
Л	AND VARIOU	
4.	ALL DEVICES BE RELOCATE BE REMOVED	ED) SH
5.	FOR DEVICES	
•	BOXES, WIRE SURFACES A	, CON
	SURFACES.	
6.	EXISTING COI BUILDING ELE	EMENT
	PIPING, EQUII NEEDED.	PMEN
7.	PROTECT EXI ELECTRICAL I	
8.	ALL EXISTING	
	WHERE THEY CONDUIT TO	WILL
9.		
	AND GROUTE BE DISCONNE	

## ECTION A

	1.
IPLEX RECEPTACLE	
	2
۱S	
TA WALL OUTLET	
PHONE WALL OUTLET	
	3
NTROL	
ARD READER	4
	_
	5.
X2 LIGHT FIXTURE	6
X4 LIGHT FIXTURE	
XIT LIGHT - SOLID FACE IS ILLUMINATED FACE	
MERGENCY WALL PACK WITH BUG EYES	7.
-	
NGLE POLE LIGHT SWITCH	
BERED CONSTRUCTION NOTES	8.
BERED DEMOLITION NOTES	
	1

### NOTES

RAWINGS PREPARED BY SPECTRUM DESIGN ARE BASED ON NON-NSPECTION. PRIOR TO ANY DEMOLITION, THE CONTRACTOR SHALL VERIFY THAT CONDITIONS IN THE FIELD ARE AS SHOWN IN THE TRACTOR SHALL NOTIFY SPECTRUM DESIGN IMMEDIATELY IF R FROM THOSE SHOWN ON THE DOCUMENTS.

WIRE, CONDUIT, AND ALL APPURTENANCES ASSOCIATED WITH ED TO BE REMOVED MUST BE REMOVED BACK TO LAST ACTIVE. PANELBOARD, UON. ENSURE THAT THE CIRCUIT REMAINS ACTIVE REMAIN IF OTHER DEVICES ON THAT CIRCUIT ARE REMOVED ND THE BRANCH CIRCUIT PANELBOARD. IF CIRCUIT BREAKER IS BREAKER AND REVISE CIRCUIT DIRECTORY.

I REMOVING DEMOLITION ITEMS AND REPAIR OR REPLACE ANY TO EXISTING CONSTRUCTION AND EQUIPMENT TO REMAIN.

ZARDOUS MATERIALS ARE ENCOUNTERED DURING DEMOLITION, DO EDIATELY NOTIFY THE ARCHITECT AND SUSPECTED HAZARDOUS, EGULATED, MATERIALS ENCOUNTERED DURING DEMOLITION SHOULD TRANSPORTED IN ACCORDANCE WITH APPLICABLE REGULATIONS REUSED IF APPROPRIATE. THESE MATERIALS SHOULD BE HANDLED, RECYCLED ACCORDING TO ALL APPROPRIATE LOCAL, STATE AND NES FOR SUCH MATERIALS. THESE MATERIALS CAN INCLUDE. FED TO, PCB-CONTAINING LIGHT BALLASTS, FLUORESCENT LIGHT CFC-CONTAINING MATERIALS, POTENTIAL RADIOACTIVE MATERIALS PES OF BATTERIES.

FIXTURES THAT ARE REMOVED DURING DEMOLITION (AND NOT TO HALL BE BECOME THE PROPERTY OF THE CONTRACTOR AND IS TO PLETELY FROM THE PROJECT SITE.

EQUIPMENT TO BE REMOVED AND NOT REINSTALLED, JUNCTION NDUIT AND ASSOCIATED APPURTENANCES SHALL BE REMOVED. ALL BE PATCHED/PAINTED BY CONTRACTOR TO MATCH ADJACENT

IS TO REMAIN NOT ASSOCIATED WHICH CONFLICT WITH NEW TS, INCLUDING BUT NOT LIMITED TO MECHANICAL DUCTWORK, IT, OR DROP CEILINGS SHALL BE REWORKED TO COORDINATE AS

G ELECTRICAL PANELS, MOTOR CONTROLLERS, AND OTHER PMENT FROM PHYSICAL DAMAGE AND CONSTRUCTION DUST.


DUITS AND WIRING THAT WILL NOT BE REUSED SHALL BE REMOVED . BE EXPOSED UPON COMPLETION OF NEW WORK. EXISTING IN CONCEALED IN WALLS SHALL BE ABANDONED.

IN BELOW FLOOR SLAB SHALL BE CUT OFF ONE INCH BELOW FLOOR JSH. ALL EXISTING WIRING IN CONDUITS TO BE ABANDONED SHALL D FROM POWER SOURCE AND REMOVED.

### INSTALLATION SHALL BE IN STRICT COMPLIANCE WITH THE NATIONAL ELECTRICAL CODE, UNIFORM STATEWIDE BUILDING CODE, AND MANDATES OF THE LOCAL BUILDING OFFICIALS.

- THE GENERAL ARRANGEMENT AND LOCATIONS OF LIGHT FIXTURES, OUTLETS AND EQUIPMENT IS INDICATED BY THE DRAWINGS AND SHALL BE INSTALLED IN ACCORDANCE THEREWITH, WITH THE EXCEPTION OF SUCH CHANGES WHICH MAY BE NECESSARY TO COORDINATE WITH EXISTING CONDITIONS. ELECTRICAL CONTRACTOR SHALL COORDINATE WORK WITH INSTALLATION OF OTHER CONTRACTORS, WITH EXISTING CONDITIONS, AND WITH OWNER SUPPLIED EQUIPMENT AND FURNISHINGS
- INSTALLATION OF LIGHT FIXTURES SHALL BE COORDINATED WITH CEILING LAYOUT, STRUCTURAL MEMBERS AND ADJACENT FINISHES.
- MAJOR ITEMS ARE SHOWN ON THE PROJECT PLANS. CONTRACTOR SHALL BE RESPONSIBLE FOR ALL INCIDENTAL ITEMS REQUIRED TO PROVIDE A COMPLETE AND FUNCTIONAL SYSTEM.
- ELECTRICAL WORK SHALL BE COORDINATED WITH THE GENERAL CONTRACTOR AS TO SCHEDULING, DIMENSIONING AND LOCATION OF EQUIPMENT.
- COORDINATE WITH ALL SECTIONS OF THE CONTRACT DOCUMENT TO PROVIDE PROPER ELECTRICAL POWER AND CONTROL CONNECTIONS FOR ARCHITECTURAL EQUIPMENT SUCH AS MOTORIZED DOORS, PROJECTION SCREENS, TELEVISIONS, TELEVISION MONITORS. COORDINATE WITH THE ARCHITECT/ENGINEER FOR LOCATIONS OF CONTROLLERS.
- WIRE SHALL BE COPPER OF MINIMUM OF 12 GAUGE SIZE AND SHALL BE TYPE THW, THWN, THHN, AND STRANDED IF NUMBER 8 AWG OR LARGER. WIRE SHALL BE RATED FOR 75 DEGREES MINIMUM. AND CONDUCTOR SIZES SHALL BE SELECTED BASED UPON 75 DEGREE WIRE. PROVIDE OVERSIZED WIRE FOR LONG CIRCUIT RUNS TO MAINTAIN VOLTAGE DROP WITHIN 3% AT FULL LOAD. 120 VOLT EXAMPLE: FOR 20 AMP CIRCUIT WITH 13 AMP LOAD, PROVIDE #12 WIRE UP TO 70' LENGTH, PROVIDE #10 WIRE FROM 71 TO 115' LENGTH; PROVIDE #8 WIRE FROM 116 TO 185' LENGTH, AND PROVIDE #6 WIRE FOR BRANCH CIRCUITS OVER 185'.
- ALL WIRING SHALL BE IN CONDUIT. RIGID METAL WHERE EXPOSED OUTDOORS AND BELOW SWITCH HEIGHT OR SUBJECT TO DAMAGE; MC CABLE WHERE HIDDEN IN WALLS. PVC SCHEDULE 40 WHERE BELOW GRADE; FLEXIBLE METALLIC FOR EQUIPMENT CONNECTIONS AND EMT OTHERWISE. A SEPARATE GREEN INSULATED GROUND WIRE SHALL BE INSTALLED IN ALL CONDUITS. ALL CONDUIT SHALL BE NEATLY RUN AND SUPPORTED PER NATIONAL ELECTRIC CODE.
- IN FINISHED AREAS WHERE EXPOSED STRUCTURE AND BEAMS EXIST FOR ARCHITECTURAL EFFECT, CONDUITS WHICH CANNOT BE CONCEALED SHALL BE ROUTED CAREFULLY FOR BEST CONCEALMENT AND FOR ALIGNMENT WITH ARCHITECTURAL FEATURES.
- ALL CONDUIT TO BE RUN CONCEALED WHERE POSSIBLE IN FINISHED SPACES. EXPOSED CONDUIT IS ACCEPTABLE IN MECHANICAL ROOMS AND JANITOR CLOSETS PVC CONDUIT IS NOT PERMITTED IN AIR PLENUM OR EXPOSED INSIDE THE BUILDING. WHERE UNDERGROUND PVC CONDUITS ENTER THE BUILDING, CONCRETE ENCASEMENT OR METAL SHROUD MAY BE USED TO PROTECT THE PVC FROM POSSIBLE DAMAGE.
- 11. PROVIDE WEATHERPROOF SEALS ON ALL CONDUIT AND SLEEVE PENETRATIONS INTO THE BUILDING.
- SOME ELECTRICAL SYSTEM CABLING, SUCH AS FIRE ALARM, SOUND, TELEVISION, DATA 12 OR TELEPHONE MAY BE PERMITTED ABOVE ACCESSIBLE CEILING WITHOUT CONDUIT. HOWEVER, SUCH CABLING IS NOT PERMITTED TO BE EXPOSED. PROVIDE PARTIAL CONDUIT SYSTEM AS NEEDED TO PROTECT AND CONCEAL THE WIRING FROM VIEW. ANY LOCATIONS WHERE CABLES PASS ABOVE NON-ACCESSIBLE CEILINGS OR THROUGH FIRE RATED PARTITIONS SHALL UTILIZE CONDUIT AND SLEEVES WITH SEALANT TO RESTORE THE FIRE RATING OF THE PARTITION.
- 13. ALL CABLING RUN IN PLENUM AREAS ABOVE CEILING ARE TO BE PLENUM RATED UNLESS OTHERWISE APPROVED.

JNTING TYPE	COMMENTS
FACE CEILING	
FACE CEILING	

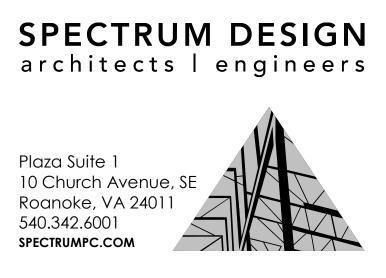

# **RENOVATIONS TO** HURT PARK **ELEMENTARY SCHOOL** SECURED VESTIBULE ROANOKE CITY PUBLIC SCHOOLS

VA DOE NO.: **#**124-42-00-102 SPECTRUM DESIGN PROJECT NO.: 22082 Jeff Wiggingto JEFFREY WIGGINGTON Lic. No. 32781

11.04.2022

PROJ. MGR.: CHECKED BY: DRAWN BY: DCV JWW CLH SHEET ISSUE DATE: 11.04.2022 PROJECT PHASE: **CONSTRUCTION DOCUMENTS** SHEET REVISIONS: **REV A 03.03.2023 ADDENDUM #1** 

